OTSEGO COUNTY ROAD COMMISSION REROOFING AND VESTIBULE RENOVATION

GAYLORD, MICHIGAN

BUILDING DATA

SITE ADDRESS
ELLSWORTH COMMUNITY SCHOOL
669 McCOY ROAD
GAYLORD, MI 49735

APPLICABLE CODES
2015 MICHIGAN REHABILITATION CODE FOR EXISTING BUILDINGS
2015 MICHIGAN BUILDING CODE SERIES

USE AND OCCUPANCY CLASSIFICATION
EXISTING B/S2
PROPOSED TO REMAIN THE SAME

CONSTRUCTION TYPE
EXISTING MBC TYPE IIB AND VB

CLASSIFICATION OF WORK
REROOF — LEVEL 1 ALTERATION
VESTIBULE RENOVATION — LEVEL 2 ALTERATION

EXISTING BUILDING AREA
TOTAL BUILDING A AREA
TOTAL BUILDING - 45,556 s.f.
B USE AREA — 3,736 s.f.
S2 USE AREA — 41,820 s.f.


SHEET INDEX

T TITLE SHEET / PROJECT INFORMATION
A1 OVERALL FLOOR PLAN
A2 WORK AREA PLANS
A3 EXTERIOR ELEVATIONS AND SCHEDULES
A4 DEMOLITION SECTIONS "A—A" & "B—B"
A5 NEW WORK SECTIONS "A—A" & "B—B"
A6 ROOF PLAN AND DETAILS
E1 ELECTRICAL LIGHTING PLAN AND SCHEDULE

ANTHONY P. ESSON
ARCHITECT
PO BOX 479 GAYLORD, MICHIGAN 49734
TELEPHONE: (989) 732-0585


DAIE

7

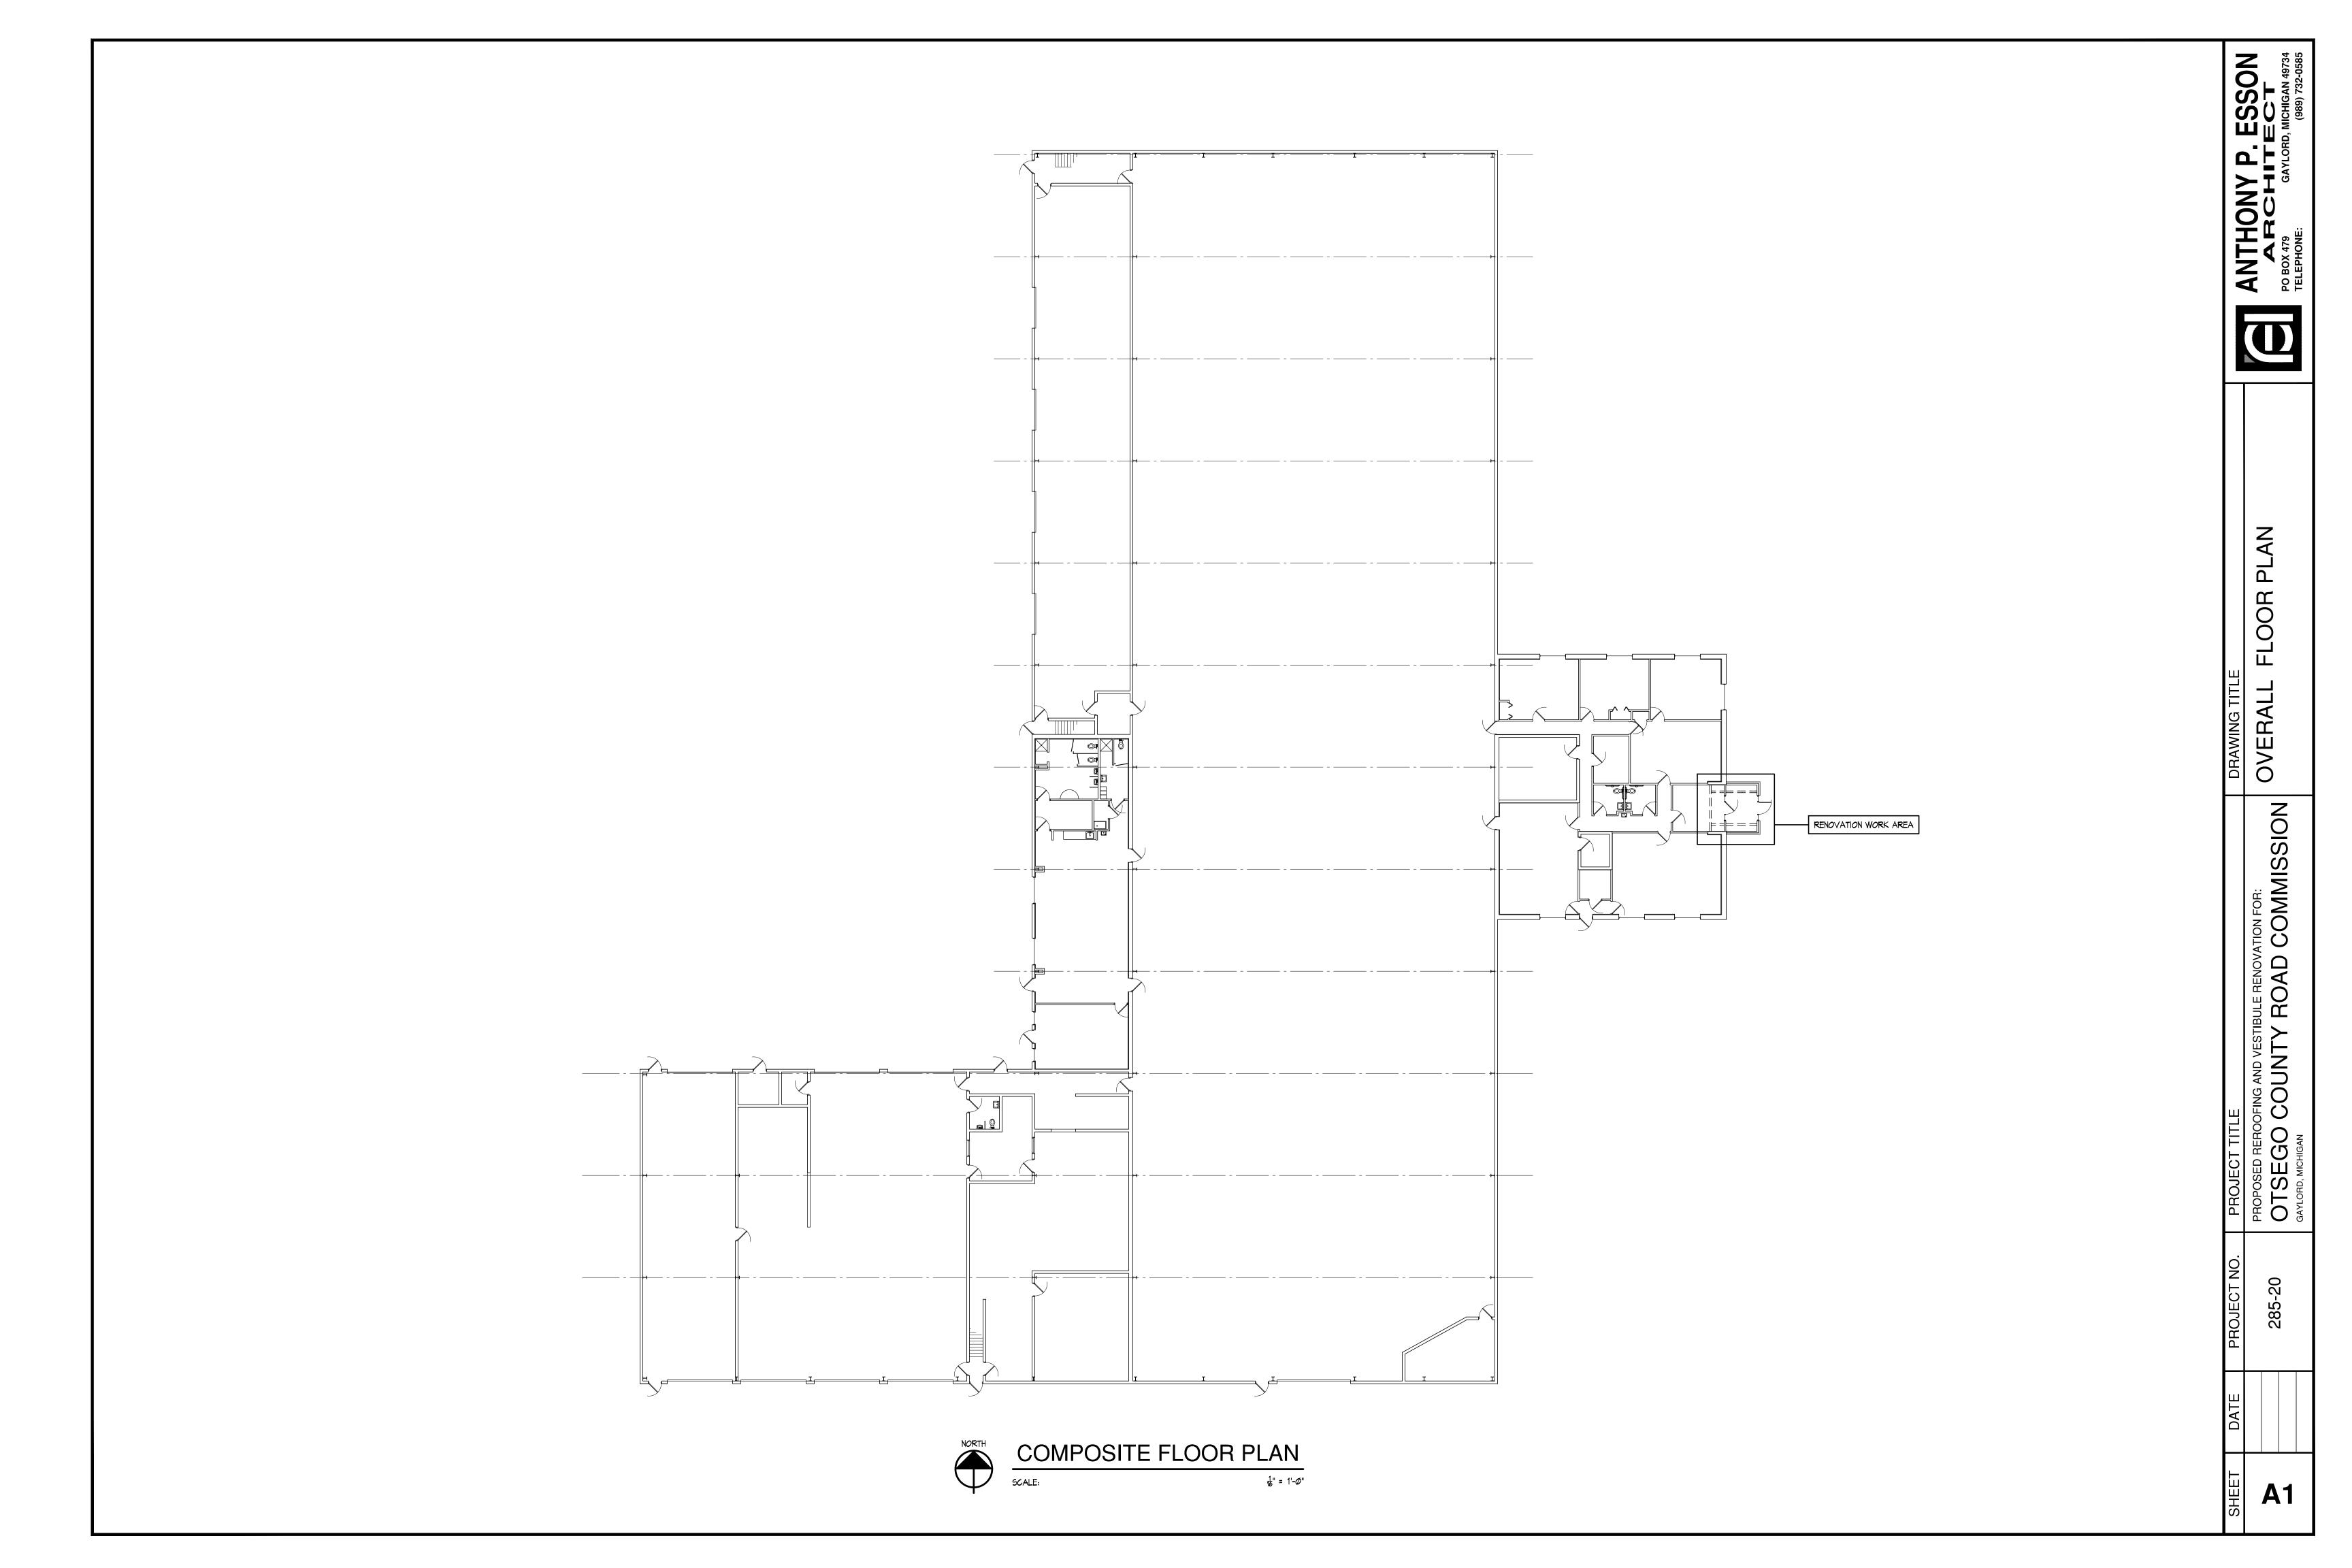

285-20 | OT GAYLC

A2

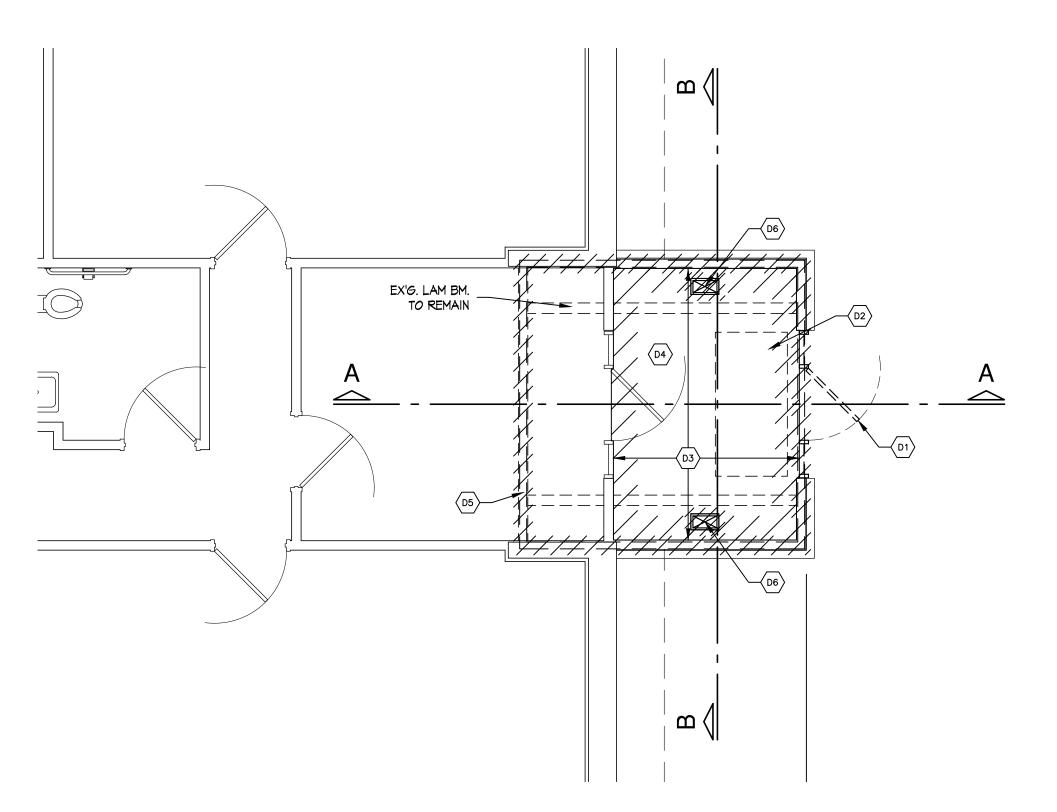



KEYED DEMOLITION NOTES

- D1) REMOVE EX'G ALUMINUM ENTRANCE.
- D2 REMOVE EX'G RECESSED ALUMINUM GRATE.
- D3 REMOVE EX'G Q.T. FLOORING AND BASE.
- REMOVE EX'G WALL FINISHES AND INSULATION FROM VESTIBULE WALL FRAMING TO REMAIN.
- REMOVE VESTIBULE TOWER CONSTRUCTION ABOVE MAIN
 BUILDING ROOF AND ABOVE 10'-0" A.F.F. ON VESTIBULE
 ANNEX. REFER TO DEMOLITION SECTIONS "A-A" AND "B-B"
 FOR ADDITIONAL DEMOLITION DESCRIPTION.

GENERAL DEMOLITION NOTES

REMOVE EX'G ASSEMBLIES TO THE EXTENT REQUIRED FOR THE
INSTALLATION OF NEW WORK, AND TO ALLOW FOR CONNECTION OF
NEW WORK TO EX'G ADJACENT CONSTRUCTION. DEMOLITION

DRAWINGS ARE DIAGRAMATIC AND EXPRESS THE OVERALL DESIGN INTENT. EXECUTION OF THE WORK MAY REQUIRE INCIDENTAL WORK NOT SPECIFICALLY INDICATED ON THE PLANS OR CALLED FOR IN

INTENT. ALL EX'G CONDITIONS ARE TO BE FIELD VERIFIED AND ALL NECESSARY INCIDENTAL WORK IS TO BE INCLUDED IN THE BID.

MODIFICATION OF BUILDING STRUCTURAL LOAD BEARING MEMBERS EXCEPT AS DESCRIBED HEREIN OR APPROVED BY THE ARCHITECT

IN WRITING IS STRICTLY PROHIBITED. STRUCTURAL MODIFICATIONS

DEPICTED HEREIN ARE BASED UPON INFORMATION DERIVED FROM THE OWNERS RECORD. CONTRACTOR SHALL REMOVE FINISHES


FROM FRAMING AND SHALL CONSULT ARCHITECT FOR DIRECTION

ON MODIFICATION OR REMOVAL OF LOAD BEARING STRUCTURAL

ITEMS (WALLS, COLUMNS, BEAMS, JOISTS, AND TRUSSES) NOT SPECIFICALLY INDICATED HEREIN.

THE DEMOLITION NOTES IN ORDER TO ACHIEVE THE DESIGN

REMOVE EX'G S.A. GRILLE — PROTECT FLOOR DUCT TO REMAIN.

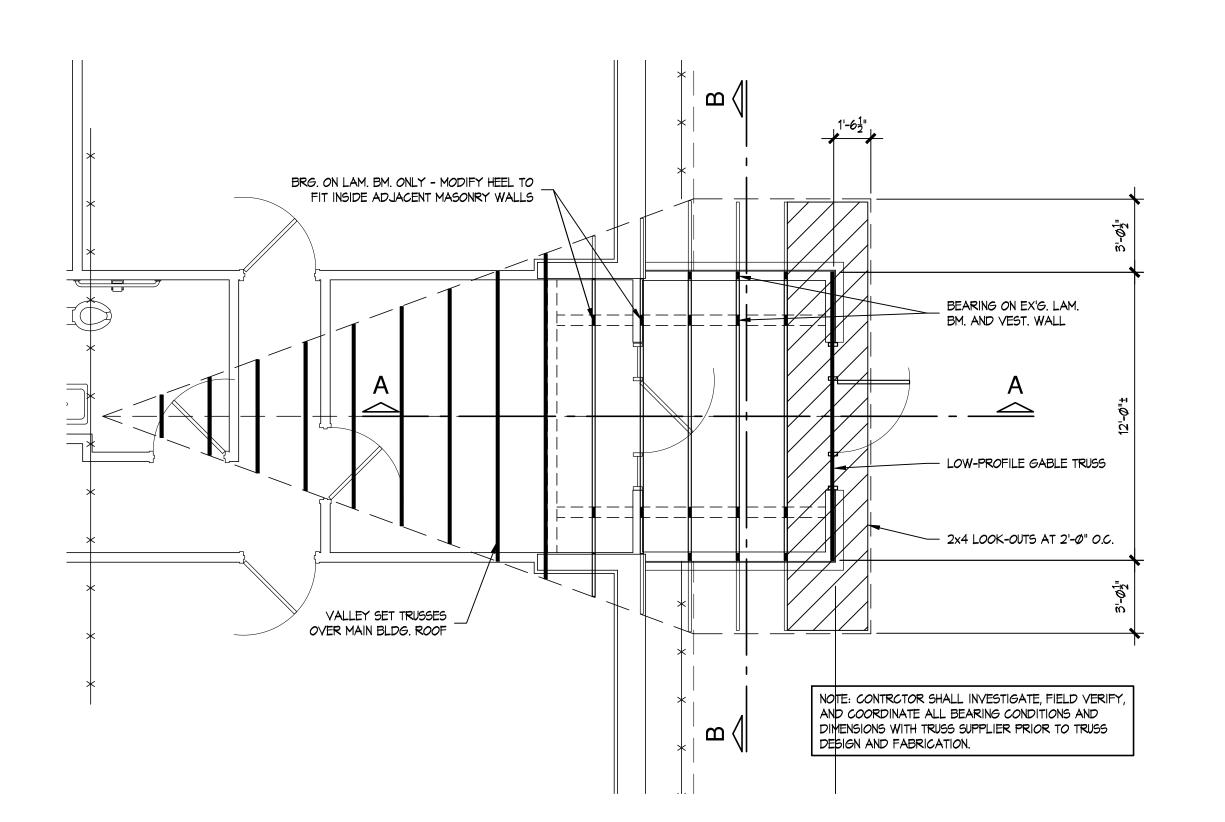

WORK AREA ROOF FRAMING PLAN

 $\frac{1}{4}$ " = 1'- \emptyset "

/ 4' LED STRIP FIXTURE - TYP.

' മ <

 $\frac{1}{4}$ " = 1'- \emptyset "

WORK AREA CEILING PLAN

K.D. PLASTER FINISH - PAINT IPS-1 -

REINSTALL EX'G. DIFFUSER PANELS


- K.D. PLASTER FINISH - PAINT IPS-1

EXIT SIGN MTD. TO ALUM. FRAME


ADJ. RECESSED LED EM LIGHT FIXTURES

ON NEW OAK SUPPORTS

SELF ILLUMINATING

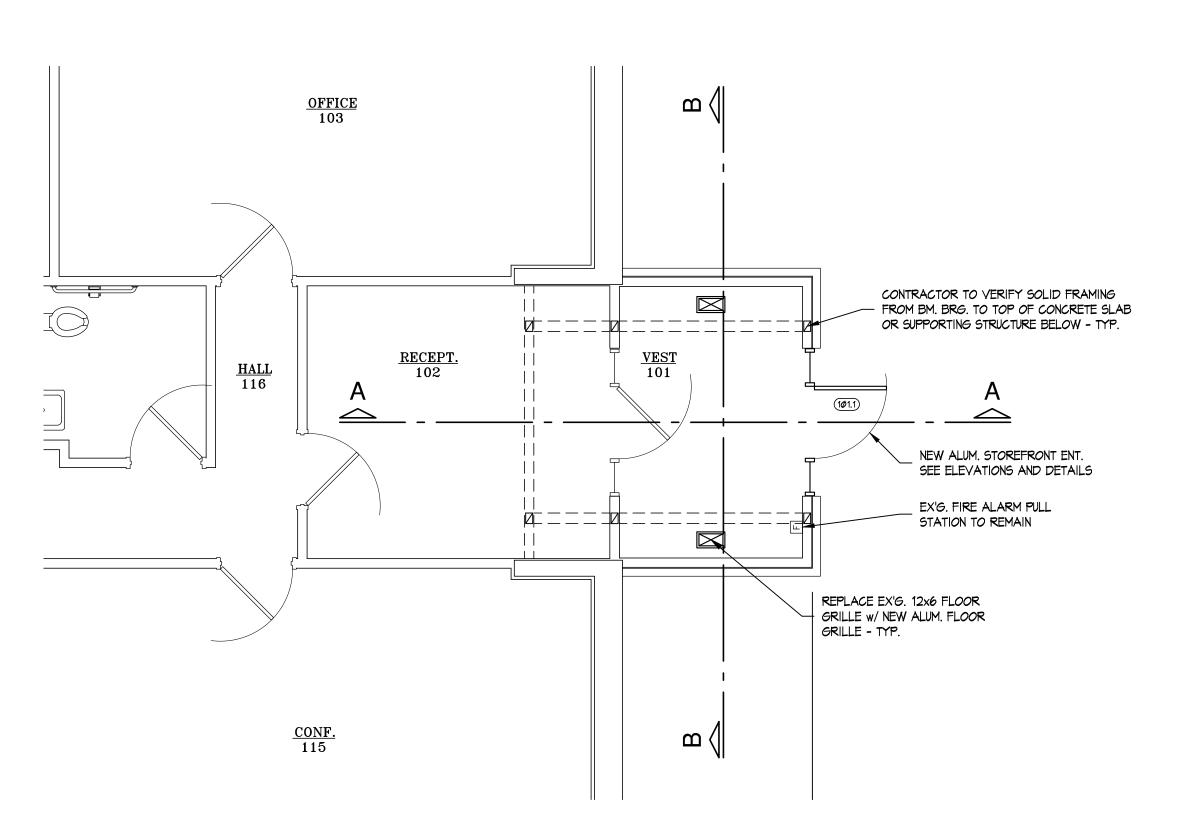




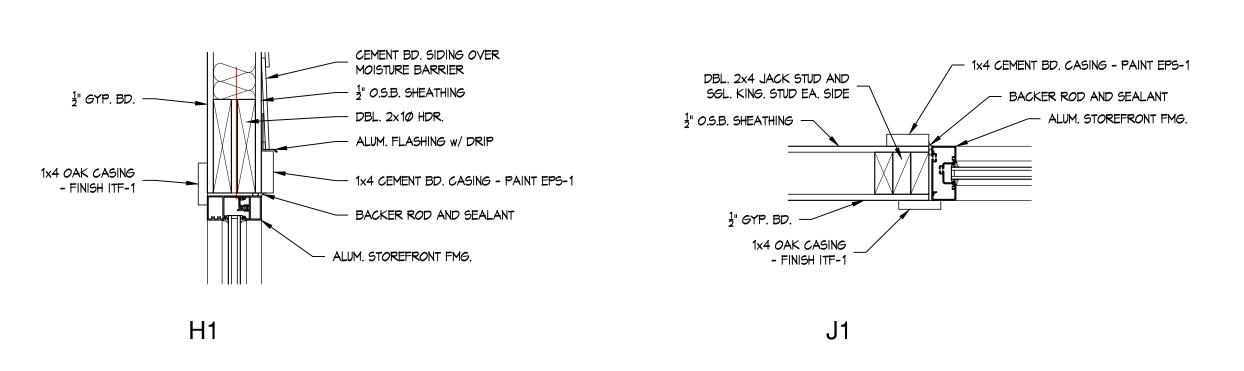

DOOR, FRAME AND HARDWARE SCHEDULE												
DOOR	DOOR SIZE	DOOR DATA		FRAME DATA		DETAILS		FIRE	HDWE	REMARKS		
NO.		MAT.	TYPE	GLAZING	MAT.	TYPE	GLAZING	HEAD	JAMB	RATING	GROUP	HEIVIARNO
1Ø1.1	3'-Ø"×7'-Ø"	AL	A	1" INSUL.	AL	1	1" INSUL.	H1	J1	-	1	


HEAD & JAMB DETAILS




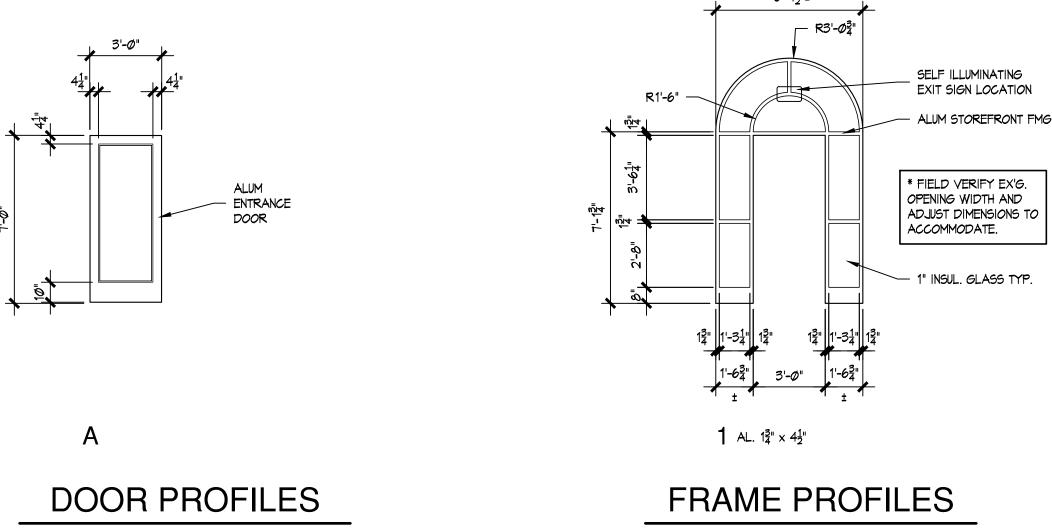






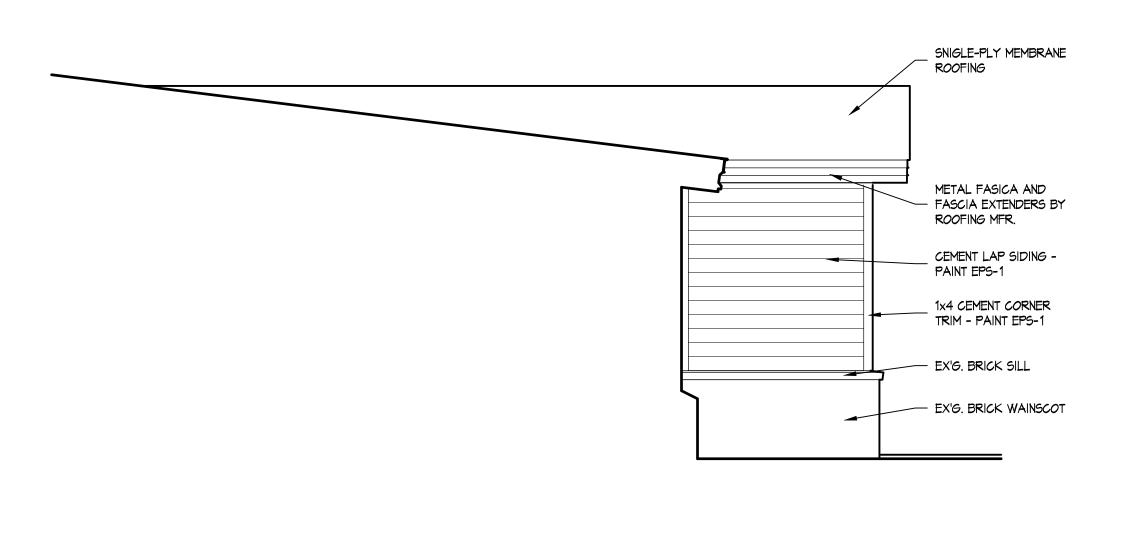

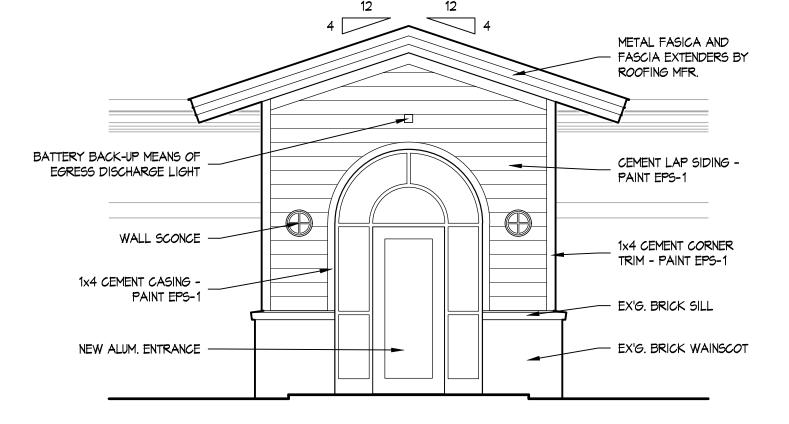

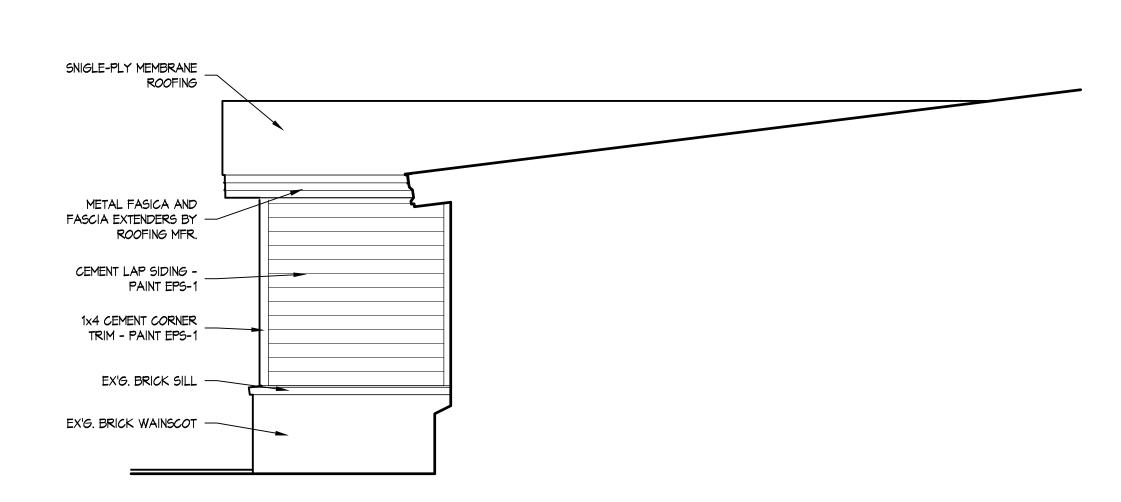

SOUTH ELEVATION					
LE:		1/4" = 1'-Ø"			

	EAST ELEVATION	
SCALE:		1/4" = 1'-Ø"

NORTH ELEVATION

SCALE:


ANTHONY P. ESSON
ARCHITECT
PO BOX 479
GAYLORD, MICHIGAN 49734
TELEPHONE:
(989) 732-0585

EXTERIOR ELEVATIONS AND SCHEDULES

Z

PROJECT TITLE
PROPOSED REROOFING AND VESTIBULE RENOVATION FOR:

OTSEGO COUNTY ROAD COMMISSIO
GAYLORD, MICHIGAN

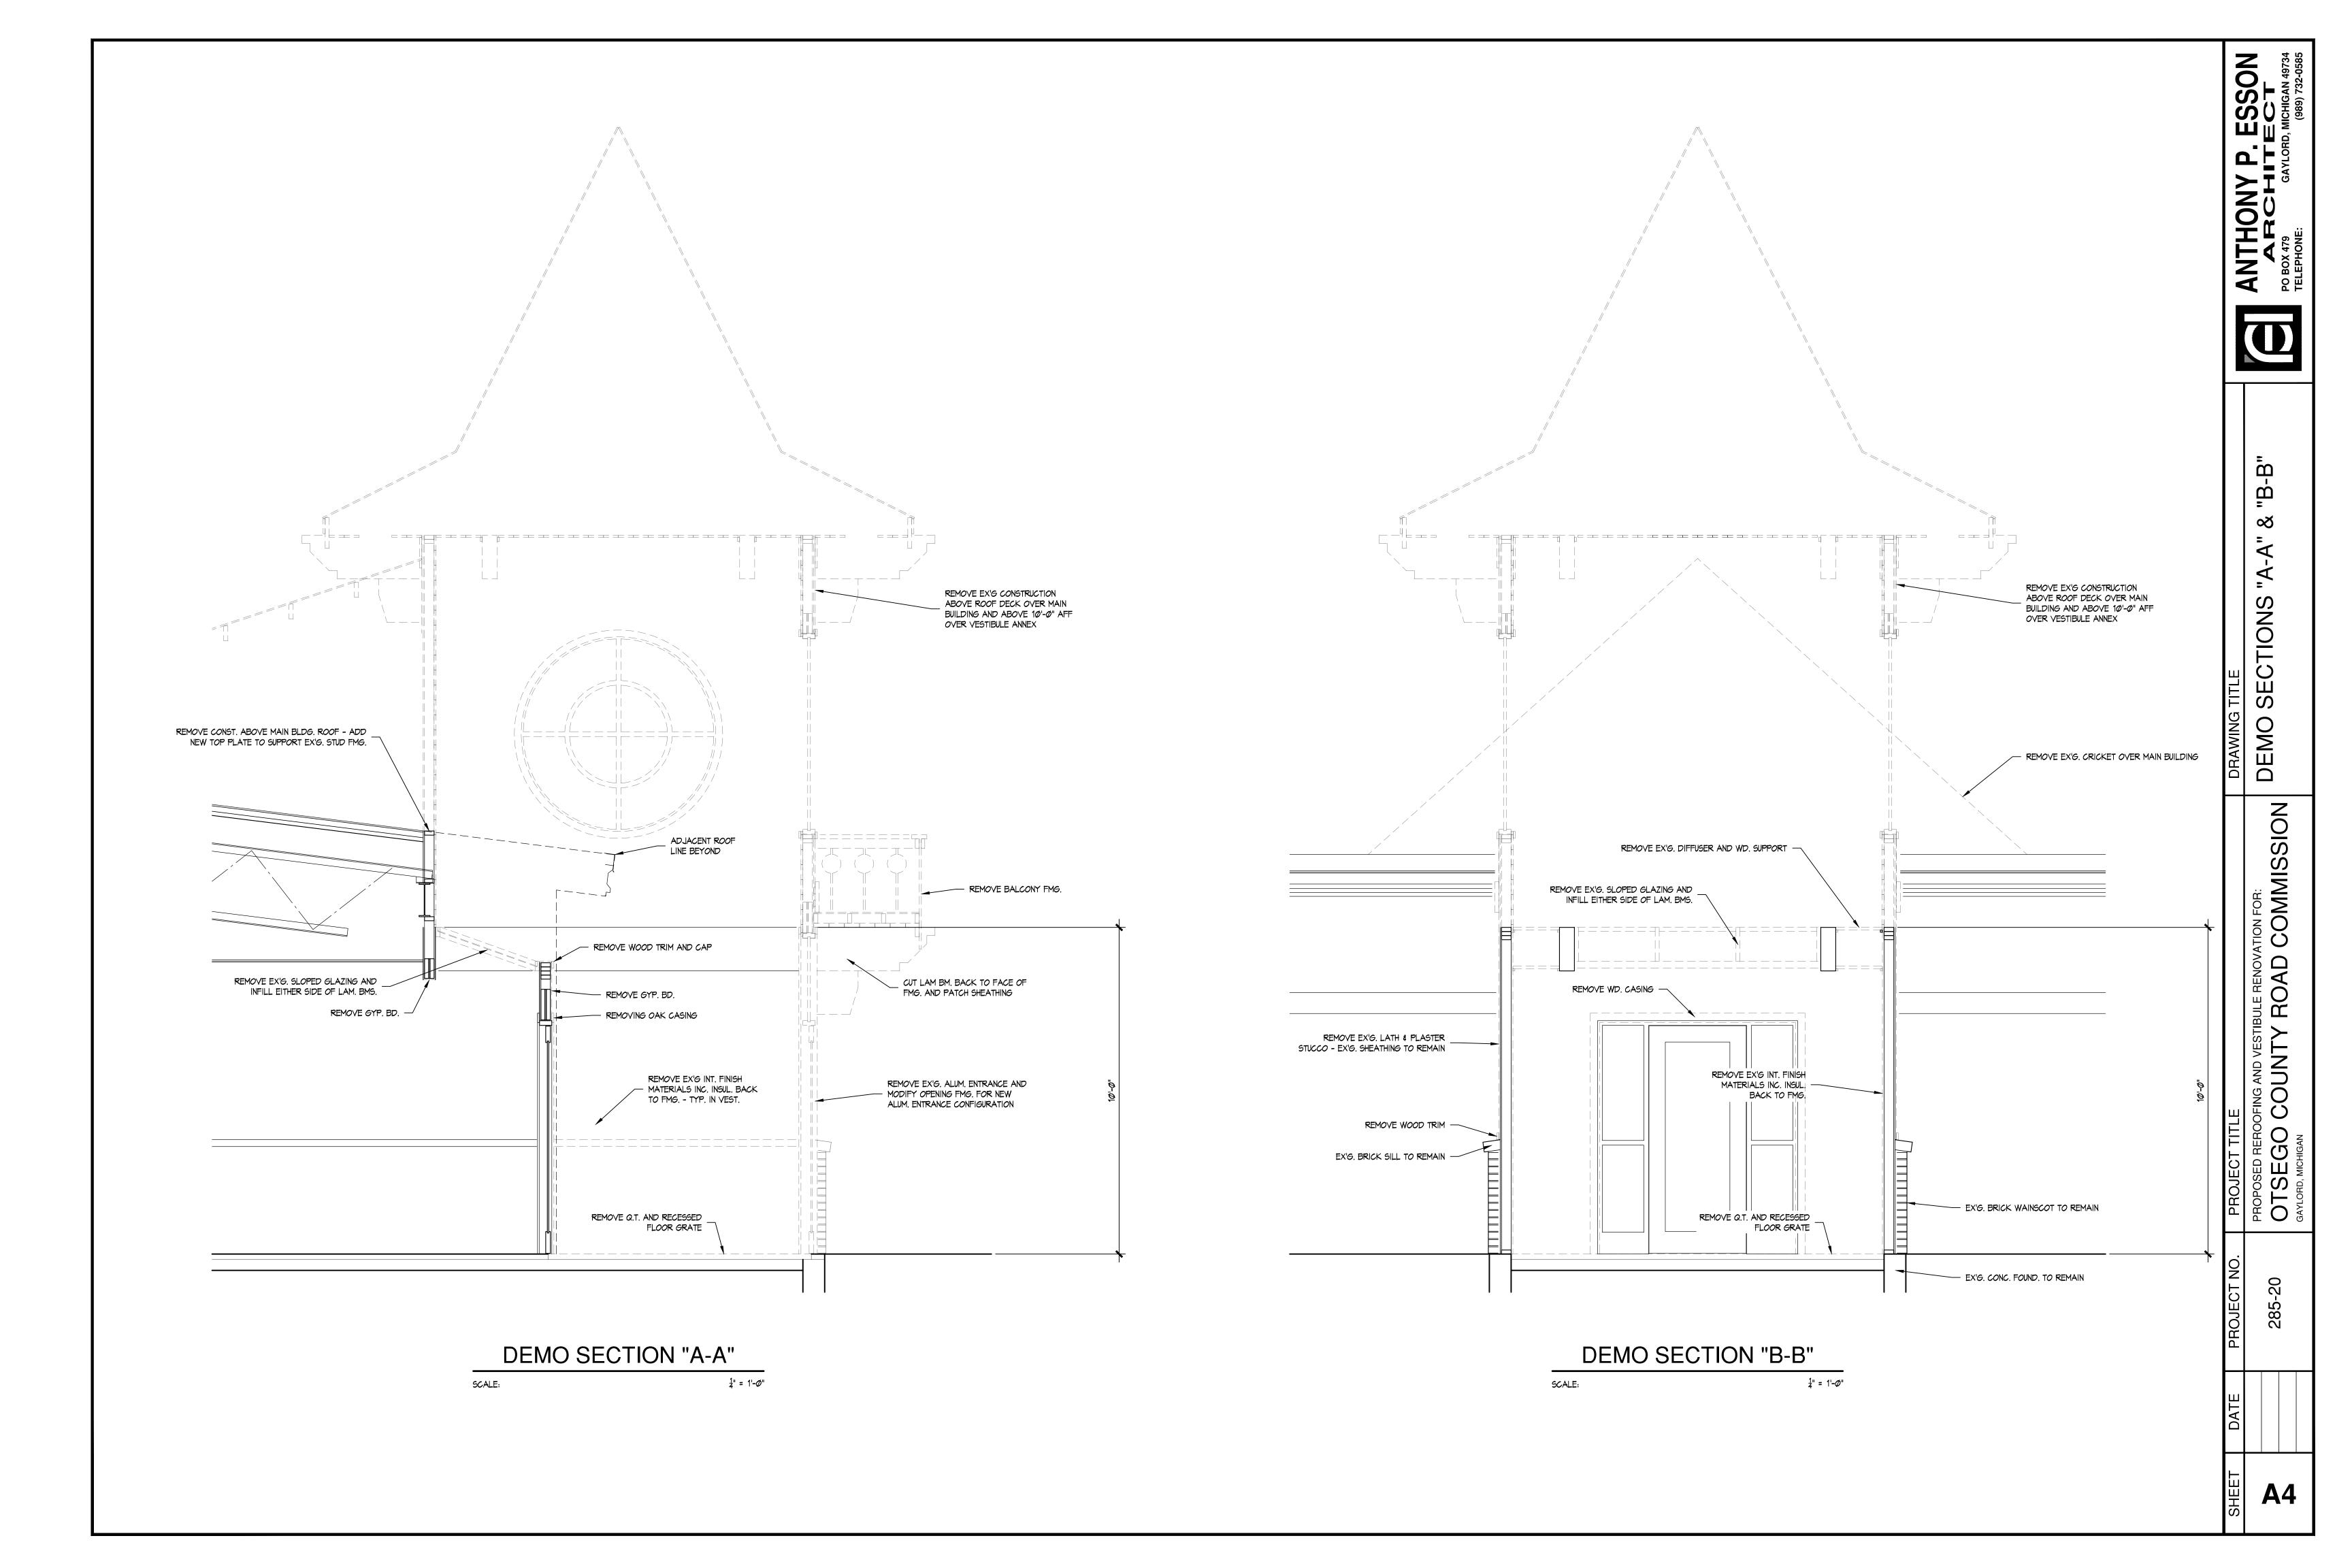





"B-B" ∞ "A-A"

SECTIONS **NEW WORK**

SINGLE-PLY MEMBRANE ROOFING ADHERED TO \$ ROOF SHEATHING

> MTL. TEE EDGE w/ FASCIA EXTENDER AND LOWER FASCIA

- 2x12 SUB-FASCIA

- PERF. ALUM. SOFFIT

- EX'G. 2x4 PLATES TO REMAIN

NEW CEMENT LAP SIDING

OVER SECONDARY MOSITURE
BARRIER - PAINT EPS-1

EX'G. 2x4 FMG. AND EXT. SHEATHING TO REMAIN TO 10'-0"

- EX'G. CONC. FOUND. TO REMAIN

 $-\frac{1}{2}$ " SHEATHING OVER TRUSS HEELS

<u>SIO</u> BOAD COMMIS COUNTY F

Z

PROJECT TITL
PROPOSED REROC

OTSEGO

GAYLORD MICHOLINGTH



12'-Ø"±

NEW PRE-ENG. WOOD TRUSSED AT 2'-0" O.C.

F GYP. BD. w/ TEAR-AWAY \$ SEALANT JOINT AT BM.

EX'G DEPRESSED SLAB (2") w/ MUDSET - PREP FOR NEW Q.T.

NEW 4' LED STRIP FIXTURE

TO REPLACE EX'G.

EX'G. LAM. BMS TO REMAIN —

EQ. (3'-9<mark>1</mark>"±)

2'-2¾"±

- R-30 BATT INSUL.

REINSTALL DIFFUSER AND OAK SUPPORT

NEW $\frac{1}{2}$ " GYP. BD. OVER EX'G FMG.

NEW R-13 BATT INSUL. IN STUD CAVITIES

NEW P.T. FLOOR


AND WALL BASE

EQ. (3'-9<mark>1</mark>"±)



2'-23"±



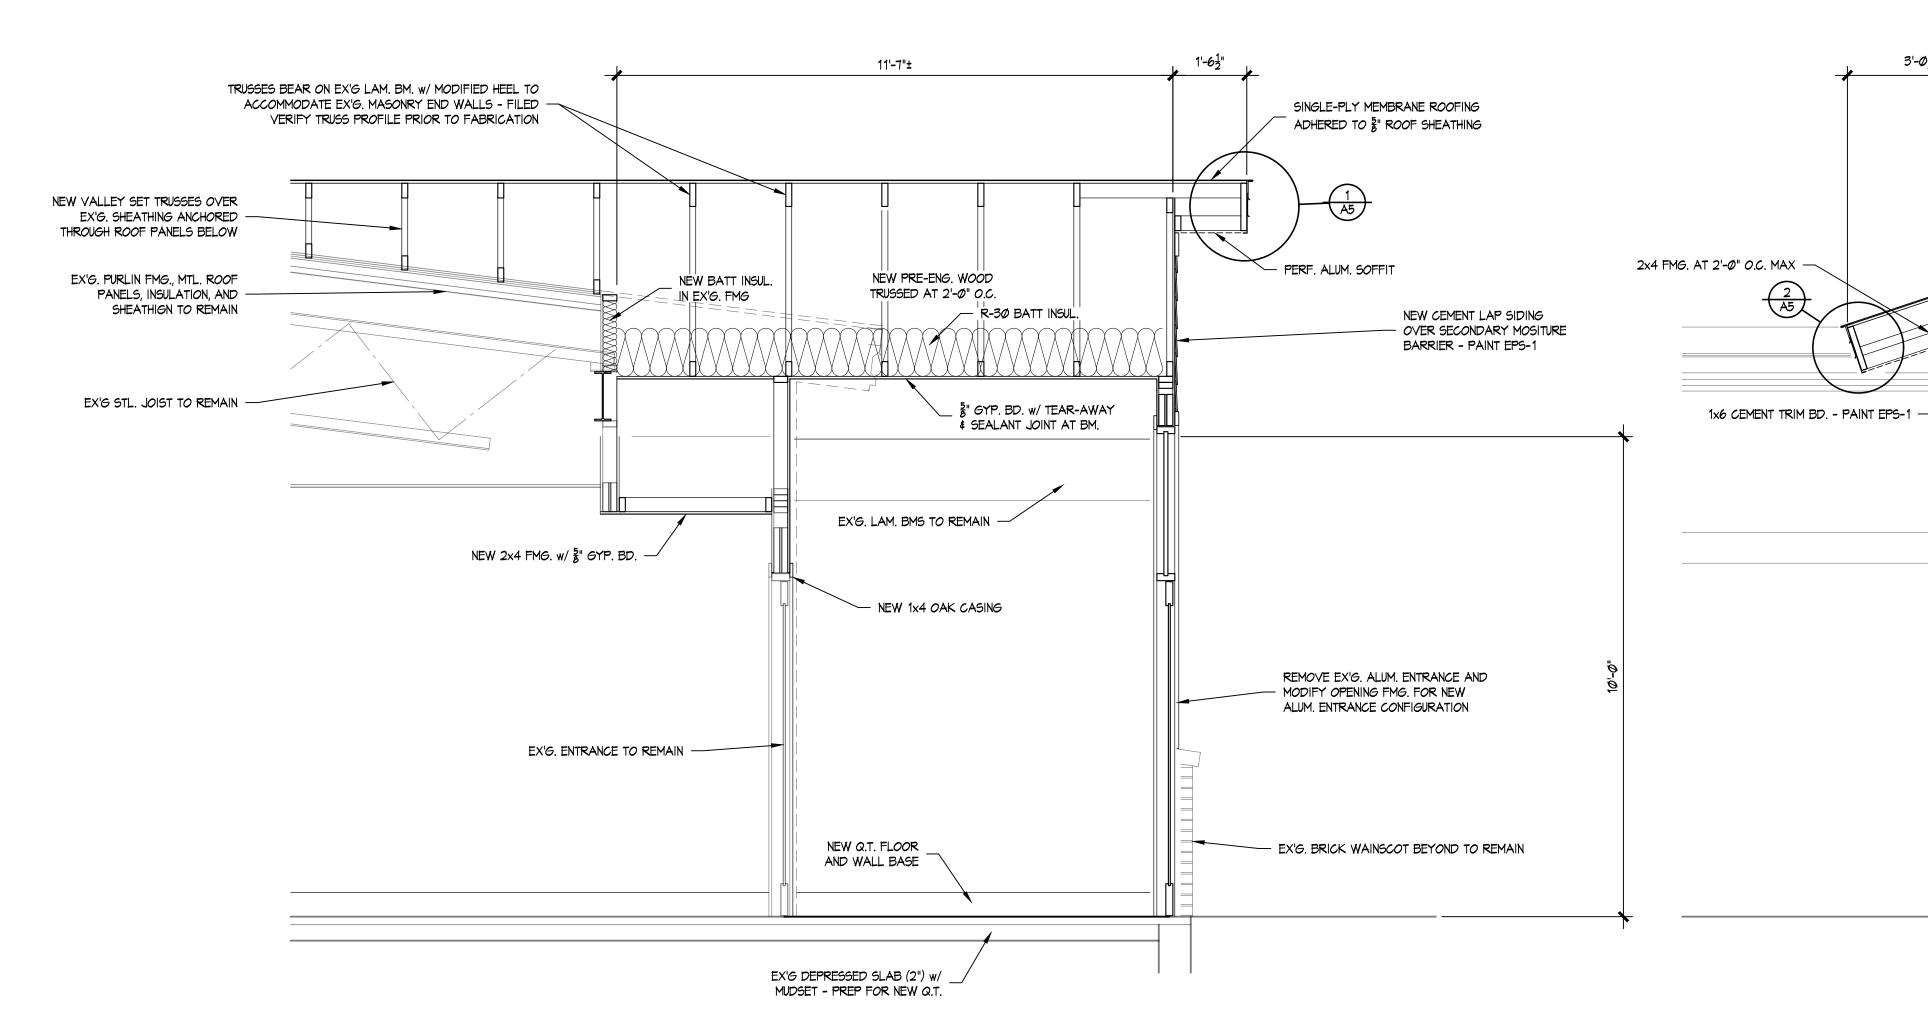



NEW WORK SECTION "A-A"

SCALE:

 $\frac{1}{4}$ " = 1'- \emptyset "

NEW WORK SECTION "B-B" SCALE:

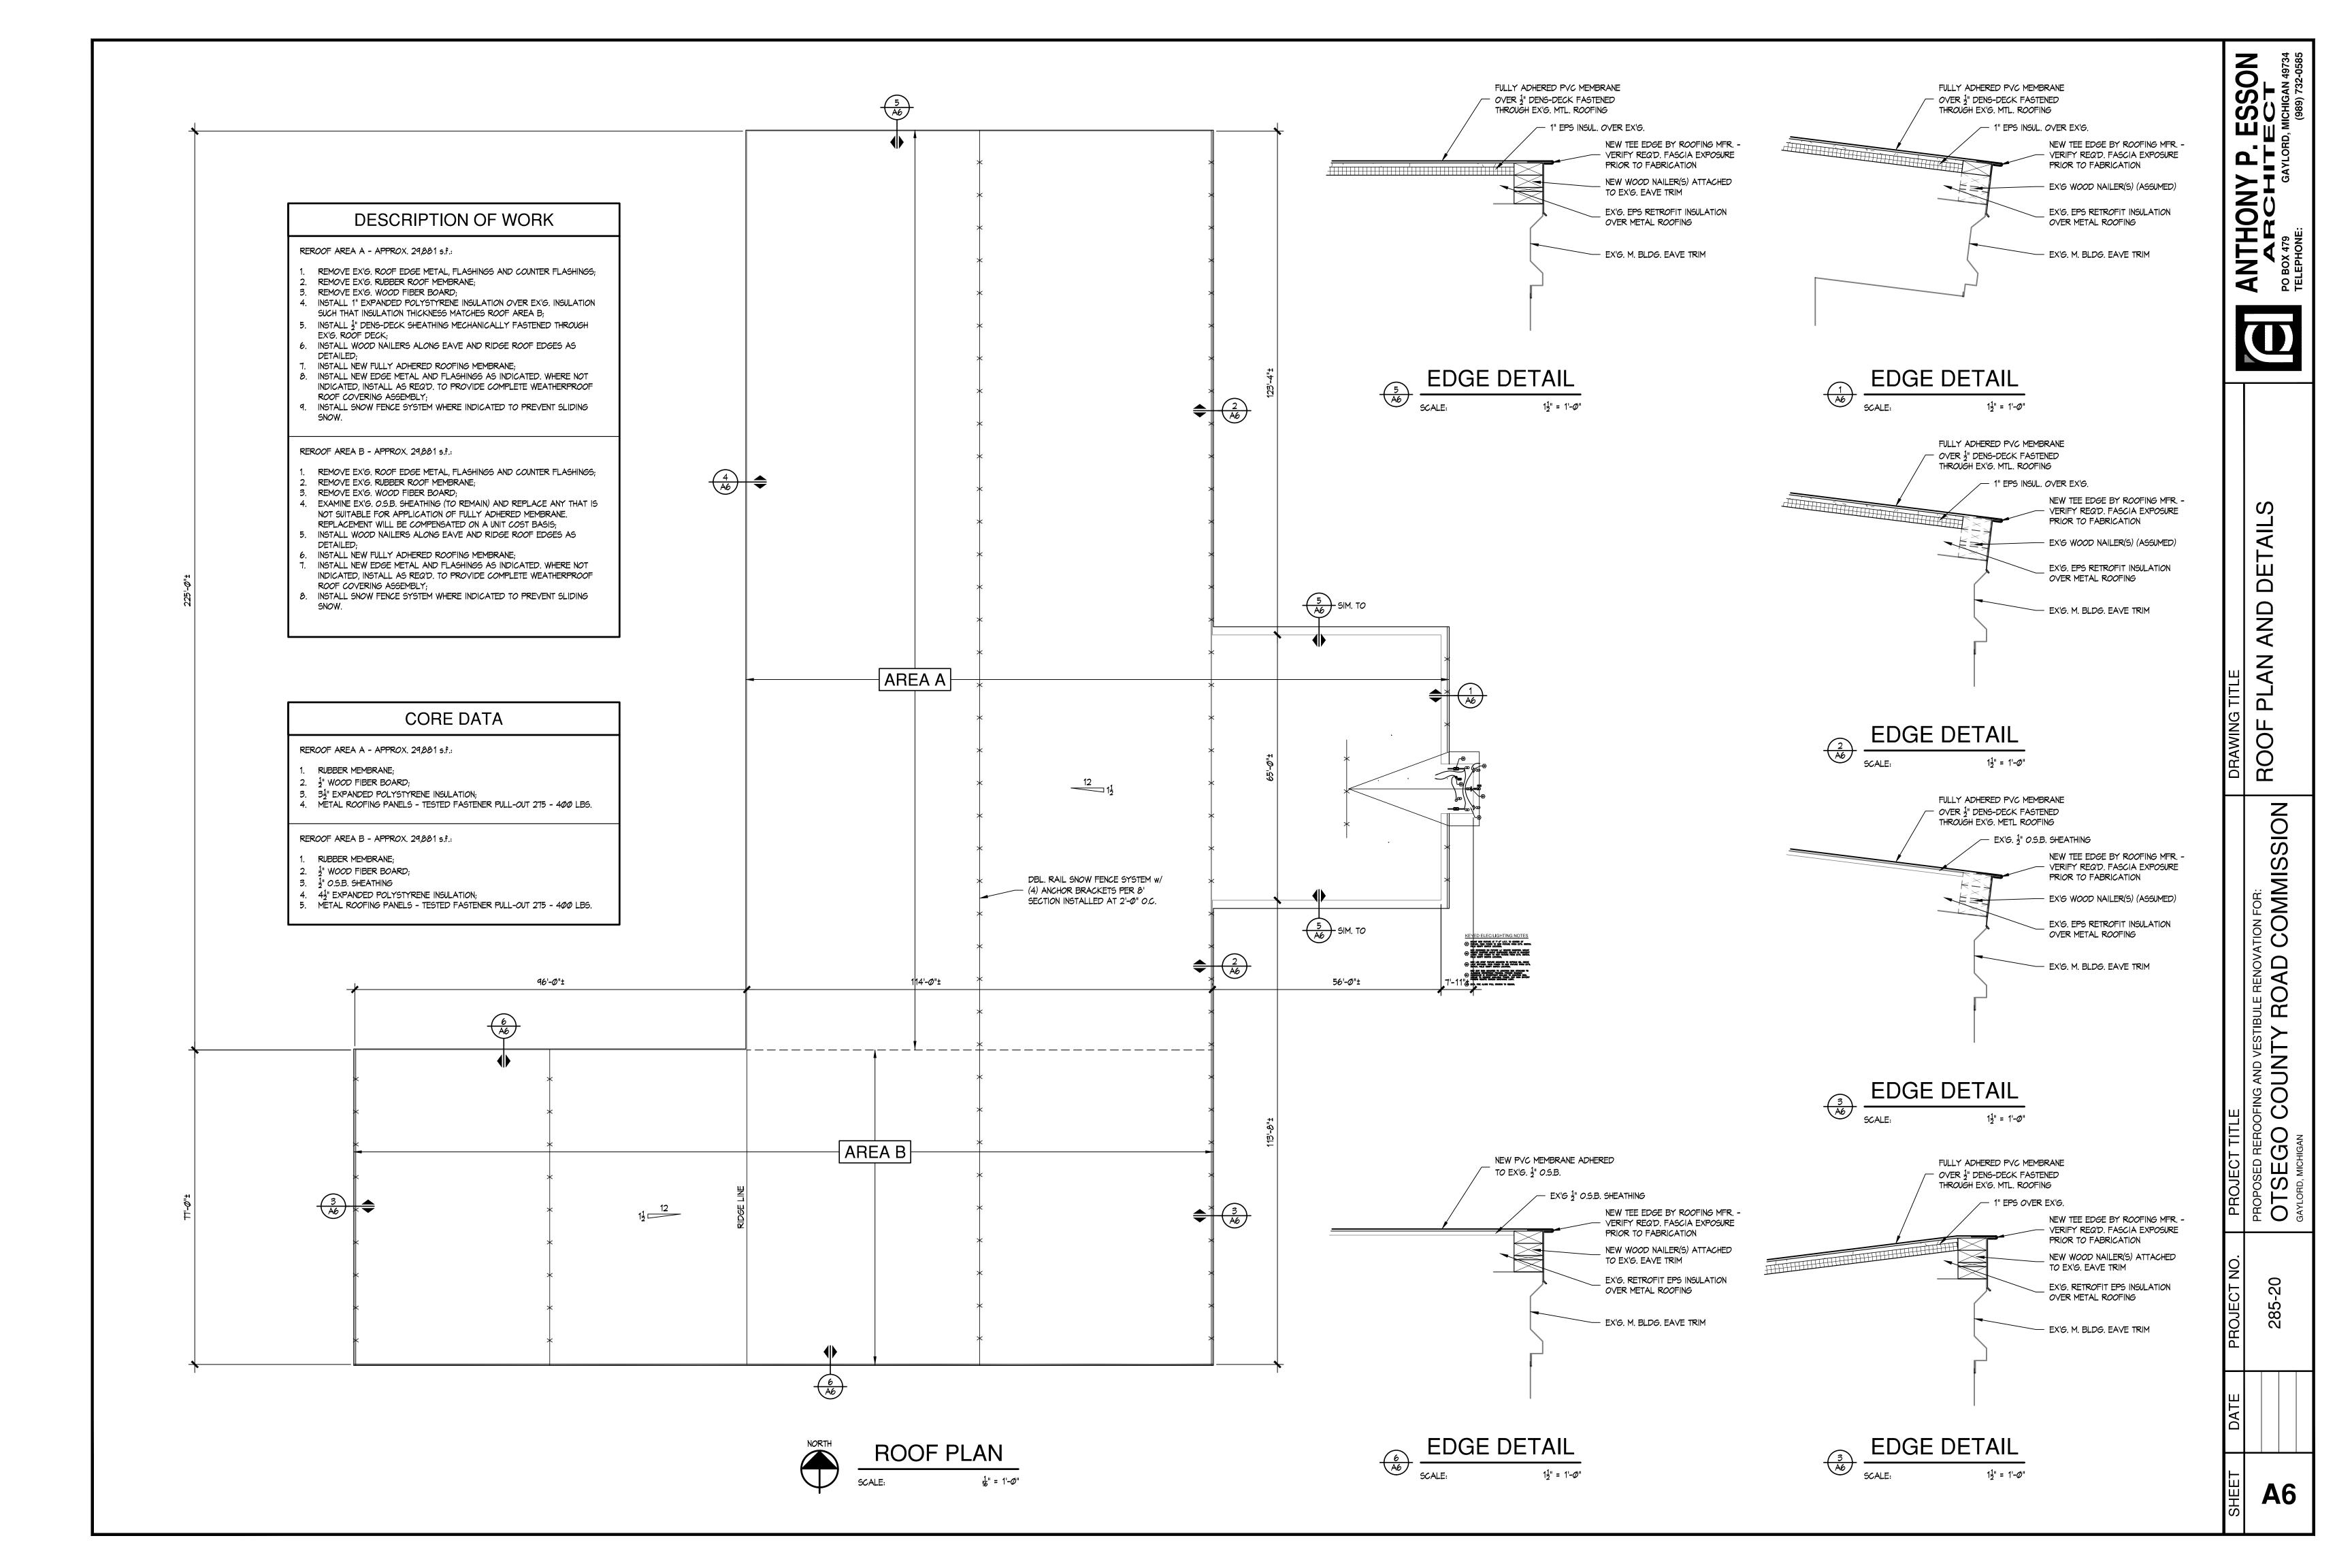

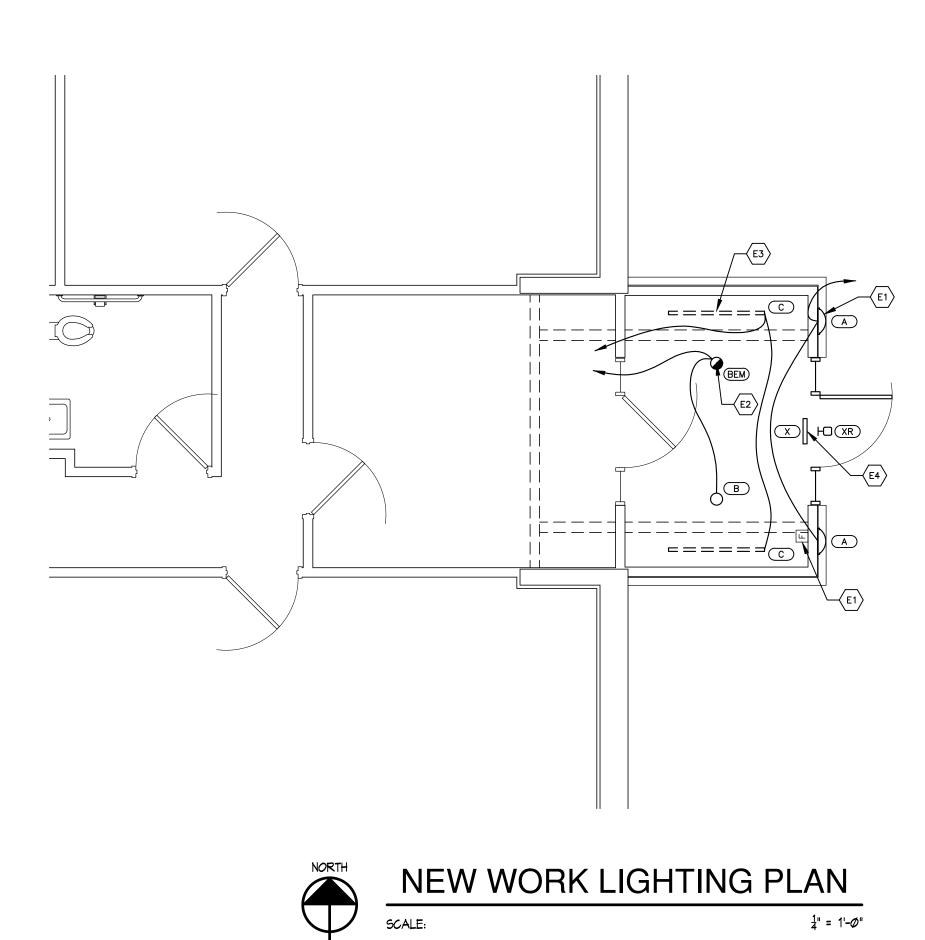

1/4" = 1'-Ø"

LIGHTING FIXTURE SCHEUDLE							
TYPE	DESCRIPTION	MANUFACTURERS	LAMPS	VOLTS/WATTS	REMARKS		
A	ARCHITECTURAL OUTDOOR ROUND DECORATIVE LED; CSA LISTED FOR WET LOCATION; DIE-CAST, MARINE GRADE ALUMINUM HOUSING, EDPM RIBBED, FOAM RUBBER GASKETING; INJECTION MOLDED POLYCARBONATE FASCIA w/ WEEP HOLES; UV-STABILIZING WHITE POLYCARBONATE DIFFUSER	1. TERON LIGHTING "HERITAGE" SERIES HRT-20.5-ZE640-100-277-CRS-xx-40K 2. ARCHITECT APPROVED EQUAL	LED 3100 LUMENS 4,000 K TEMP	100-277V / 21 W	OWNER TO SELECT COLOR		
В	SLOPE CEILING ADJUSTABLE LED DOWN LIGHT; CANLESS INSTALLATION; 9 TO 45 DEGREE SLOPE ADJUSTMENT; SELECTABLE CORRELATED COLOR TEMPERATURE	1. HALO "RL6" SERIES RLS6-15-9FS-1E-WH-DM-R w/ HL6RSMF MOUNTING FRAME. 2. ARCHITECT APPROVED EQUAL	LED 1500 LUMENS 4,000 K TEMP	120V / 19 W			
BEM	SLOPE CEILING ADJUSTABLE LED DOWN LIGHT; SAME AS TYPE B w/ REMOTE EMERGENCY POWER INVERTER	1. HALO "RL6" SERIES RLS6-15-9FS-1E-WH-DM-R W/ HL6RSMF MOUNTING FRAME. 2. ARCHITECT APPROVED EQUAL	LED 1500 LUMENS 4,000 K TEMP	120V / 19 W	w/ MYERS LVU-2 EMERGENCY INVERT		
C	LINEAR SINGLE LED STRIPLIGHT; 1.8" WIDTH DIE FORMED CHANNEL; SURFACE MOUNT	METALUX "ST" SERIES 4ST1L2040R. ARCHITECT APPROVED EQUAL	LED 1500 LUMENS 4,000 K TEMP	120V / 19.4W			
X	EXIT SIGN; DAMP LOCATION LISTED; UNIVERSAL CANOPY FOR END, WALL OR CEILING MOUNTING; COMPATIBLE w/ MVH REMOTE HEAD; DUAL RATE CHARGER; INTEGRAL AC INDICATOR AND PUSH-TO-TEST SWITCH; SOLID STATE TRANSFER RELAY; DUAL NICKLE CADMIUM BATTERIES	1. ISOLITE "RLP" SERIES RLP-R-U-WH-MTEB. 2. ARCHITECT APPROVED EQUAL	LED 184 LUMENS	120V			
XR	REMOTE LED EXIT DISCHARGE LIGHT; NEMA 4X RATING; MULTI-VOLT OPERATION; STANDARD 1.0 W HEAD; WET LOCATION, WEATHERPROOF	1. ISOLITE "MVH" SERIES MVH-GY-1-LW. 2. ARCHITECT APPROVED EQUAL	LED	1 W	POWER BY TYPE X EXIT SIGN EM BATTERY		

ANTHONY P. ESSON
ARCHITECT
PO BOX 479 GAYLORD, MICHIGAN 49734
TELEPHONE: (989) 732-0585 DRAWING TITLE
ELECTRICAL LIGHTING PLAN
AND SCHEDULE Z PROJECT TITLE
PROPOSED REROOFING AND VESTIBULE RENOVATION FOR:

OTSEGO COUNTY ROAD COMMISSIO

E1